

Sullivan Residence Lot 6, Moana Resource Consent Issue



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Concept Issue Truss Issue Building Consent Issue Building Consent RFIs Truss & Engineer Issue Amendment Amendment RFIs Resource Consent Issue 06/04/2023 17/05/2023 06/09/2023 19/02/2024 08/08/2024 10/09/2024 20/09/2024 01/10/2024

Sullivan Residence Lot 6, Moana

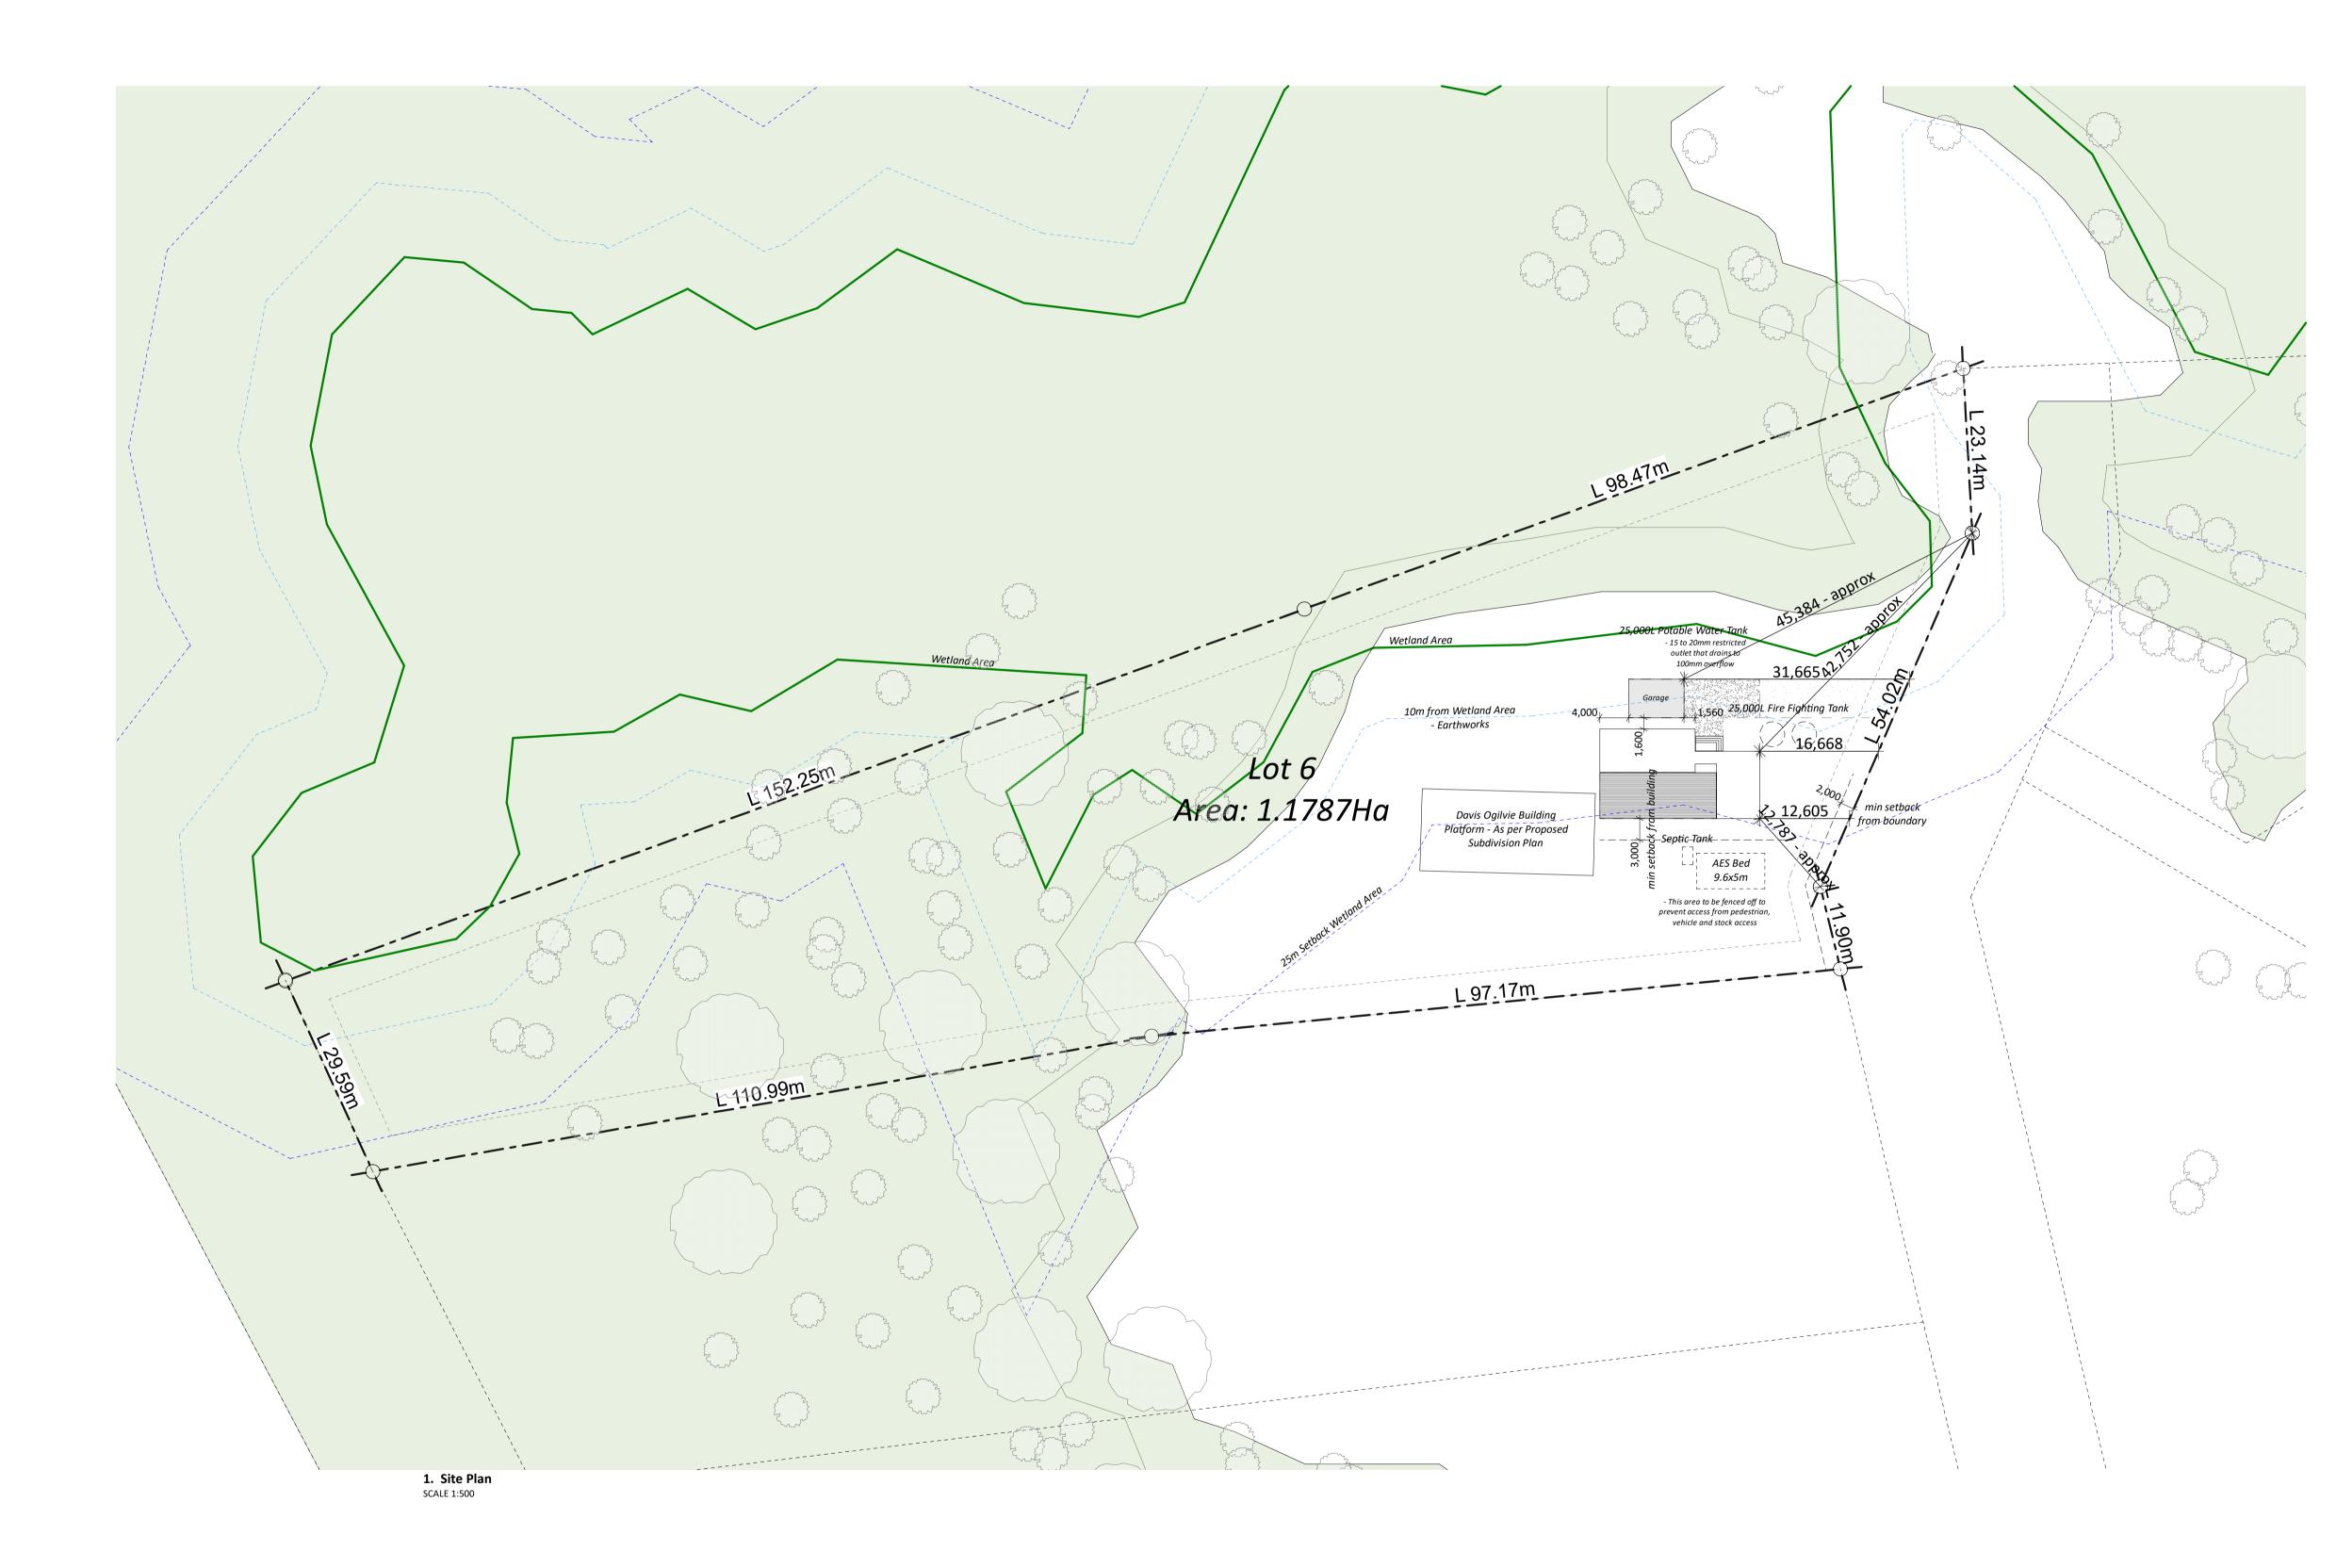
Layout	Sheet Name	
A001		Site Plan
A100		Ground Floor Plan
A101		Wall Framing Plan
A200		Elevations
A201	-	Elevations

SHEET NAME Cover Page

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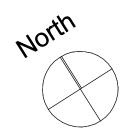


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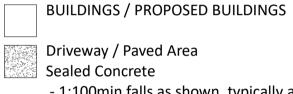


PROJECT INFO:

Address:	Lot 6 Lake Brunner Moana	Road
Legal Description:	Lot 6 DP 3411	128
Title:	-	
Site Area:	1.1787Ha (mo	ore or less)
Building Area:	House : Garage :	144.3m ² 42.12m ²
Site Coverage:	1.58%	
Planning Zone: Wind Zone: Earthquake Zone: Exposure Zone: Sea Spray Zone: Climate Zone: <u>SITE PLAN LEGEND</u>	Rural Very High 4 C - 4	

— – — Boundary Line

Boundary setback as per Grey District Plan



Driveway / Paved Area Sealed Concrete

- 1:100min falls as shown, typically away from dwelling - finish to have slip resistance to comply with NZBC D1/AS1



Gravel Driveway

SITE PLAN GENERAL NOTES

Contractor to confirm all dimensions on site.

All drawings to be read in conjunction with engineering/ consultants documentation.

Confirm all existing services on site.

Contractor to confirm with designer if there is a conflict between consultant documentation and accepts liability for decisions made without consultation.

All unpaved areas are to be a minimum of 225mm below Finished Floor Level. Paved areas to be a minimum of 150mm.

SHEET NAME Site Plan

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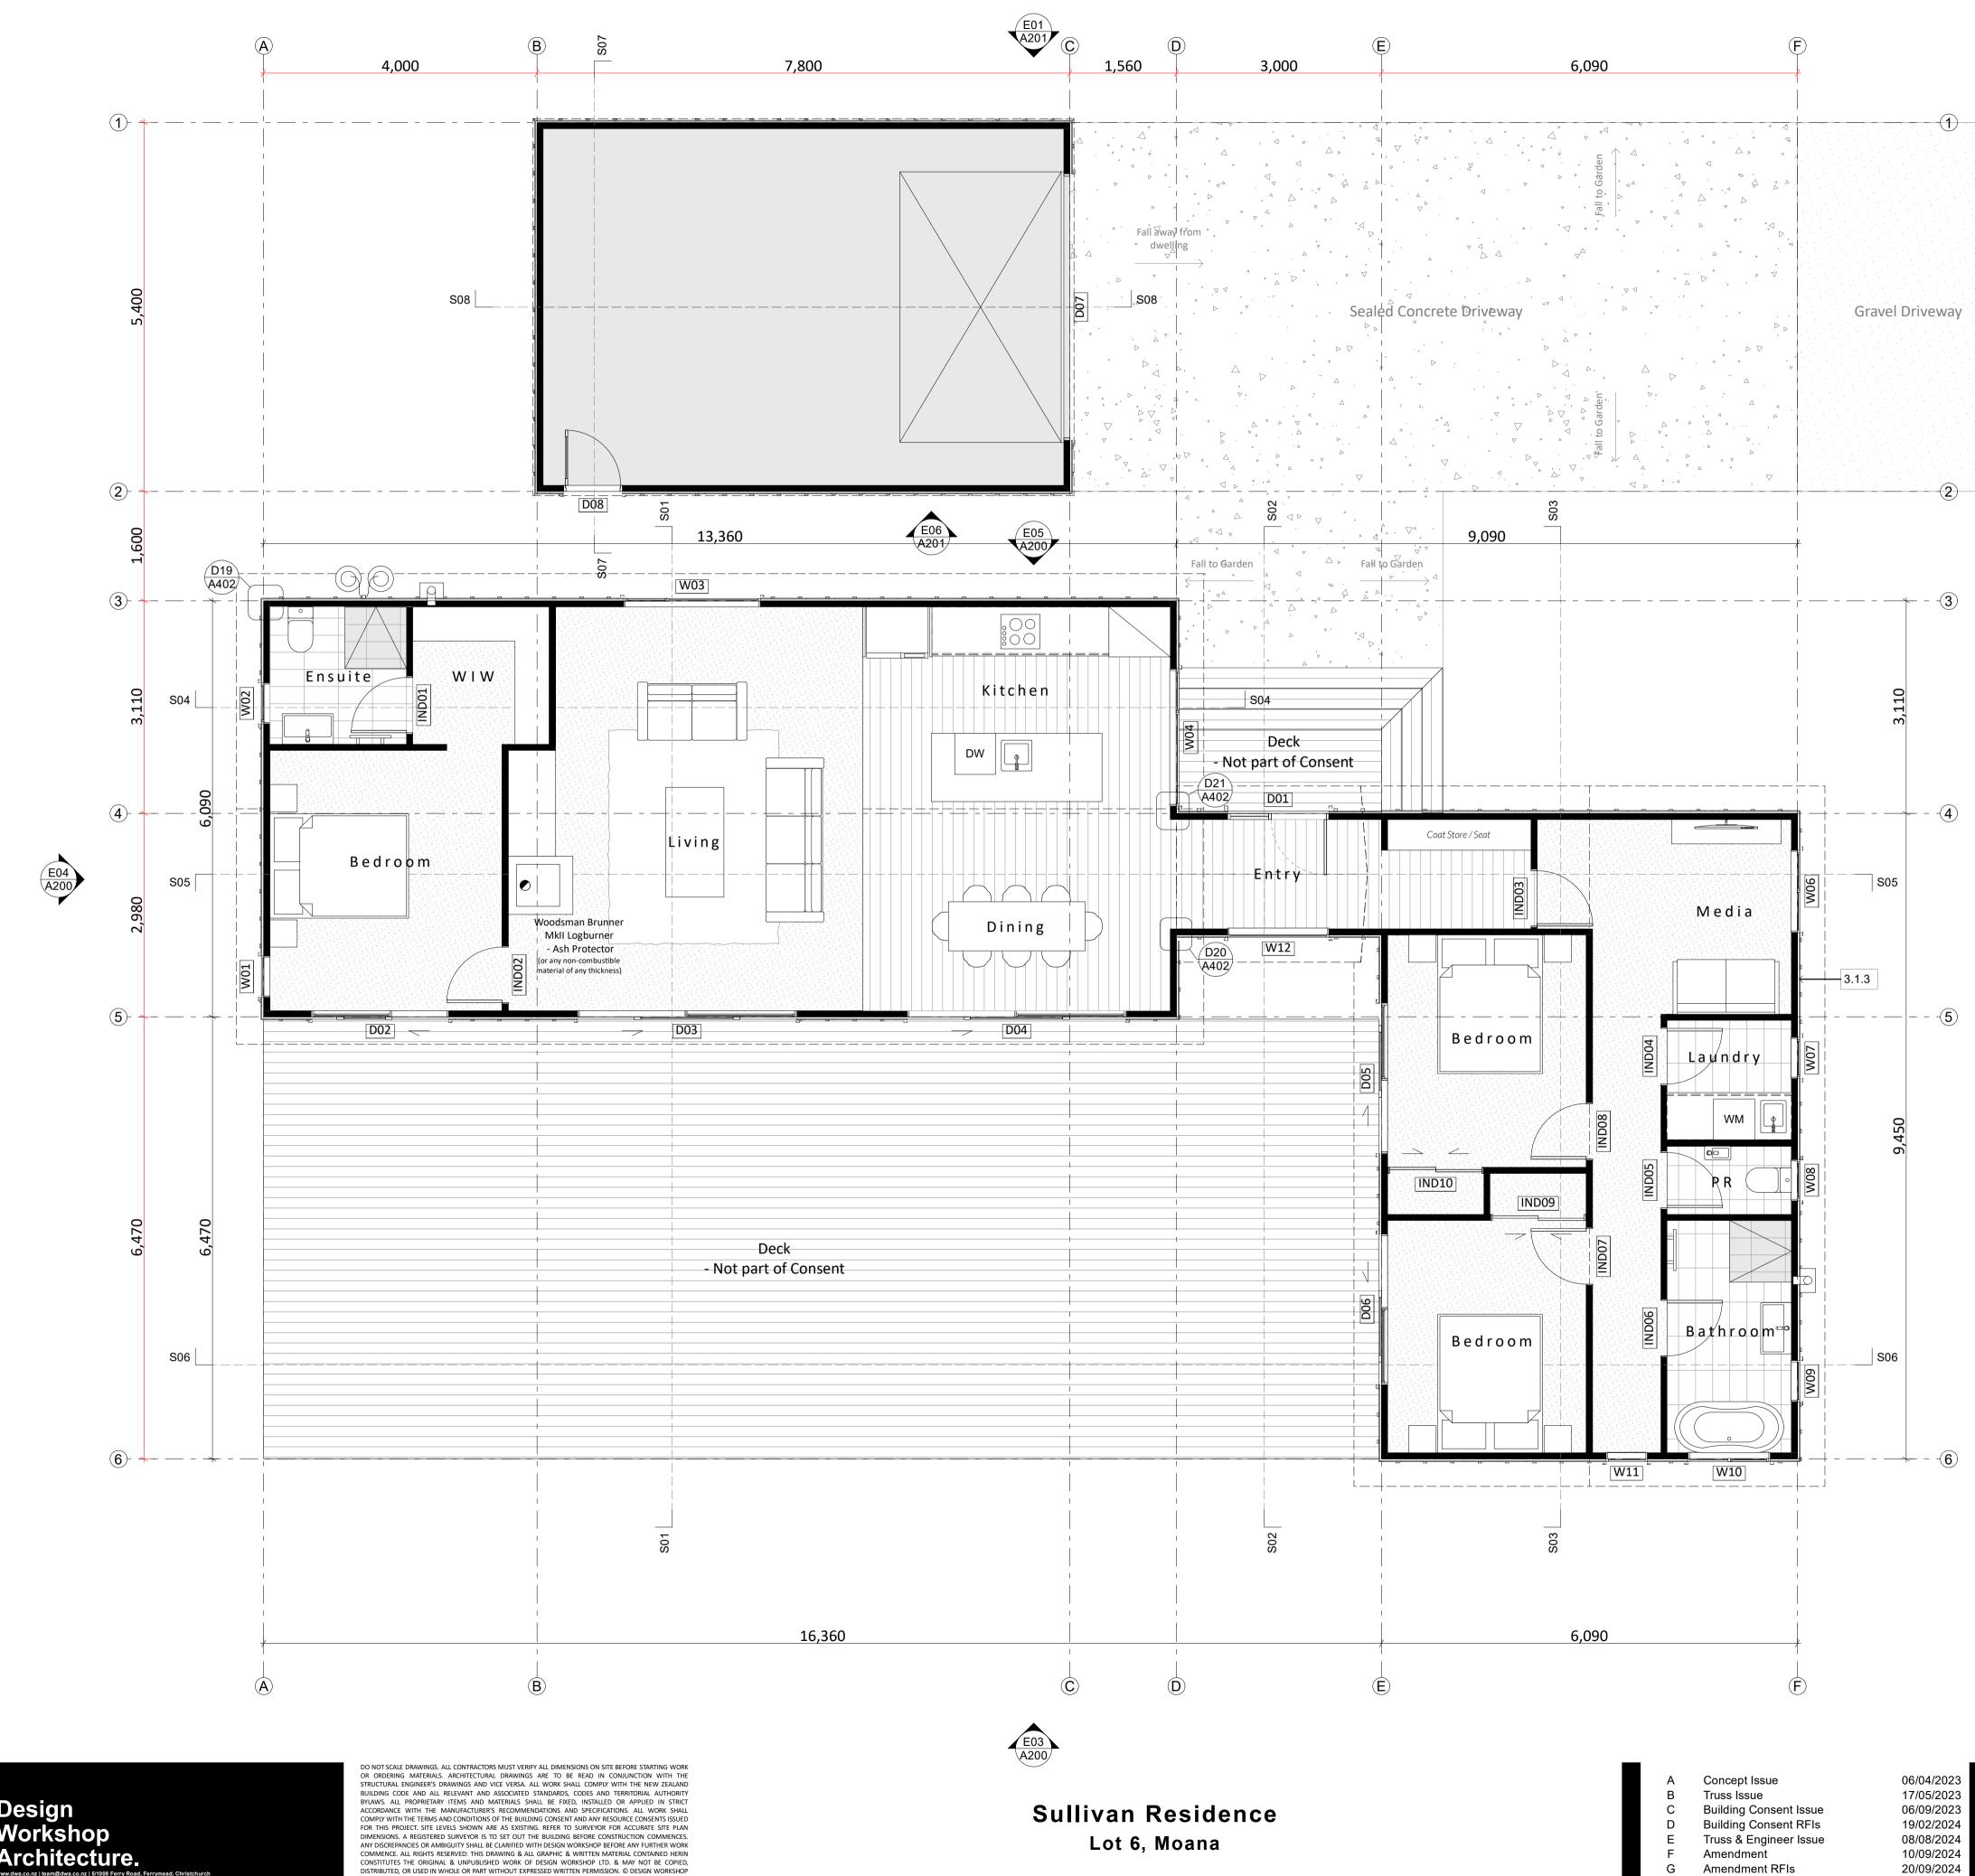


DATE JOB NO. 1/10/2024 DW1475

Sullivan Family

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North

GENERAL NOTES:

All entries and exits to be in accordance with NZBC D1/AS1.

Refer to Door and Window Schedules for lintel sizes.

LEGEND 3.1.3 BOARD & BATTEN WALL CLADDING Shadowclad Board & Batten cladding on 20mm cavity battens on 7mm Ecoply Barrier

SHEET NAME Ground Floor Plan

CLIENT Sullivan Family DATE 1/10/2024 JOB NO. DW1475

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Resource Consent Issue

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North

WALL NOTES:

Internal timber framed walls to be **<u>90x45mm</u> H1.2** SG8 timber, studs @ <u>600mm</u> crs, dwangs @ 800mm crs.

House: External timber framed walls to be 90x45mm H1.2 SG8 timber, studs @ <u>400mm</u> crs, 90x45mm SG8 H1.2 dwangs @ 800mm crs, unless noted otherwise.

Garage: External timber framed walls to be 90x45mm H1.2 SG8 timber, studs @ <u>300mm</u> crs, 90x45mm SG8 H1.2 dwangs @ 800mm crs, unless noted otherwise.

Top Plate Fixing: Top plate to be fixed to studs @ 600mm max crs with 2-90 x 3.15 end nails + 2 wire dogs or 4.7kN alternative fixing unless noted otherwise Timber Floor Bottom Plate Fixing: Fixings as per NZS 3604: 2011, table 8.19 - Nailing Schedule for hand driven

and power driven nails Bottom Plate Fixing: Proprietary anchor's @ 900mm max crs with 50x50x3mm flat washer unless noted otherwise

H1 COMPLIANCE

Calculation method is to be used.

WINDOW TO WALL RATIO: 27 %

ROOF:	x2 R3.6 (180mm) Fibreglass batts or similar
FLAT ROOF:	R1.75 (40mm) Kingspan Board or similar
WALL (90):	R2.8 (90mm) Fibreglass batts or similar
FLOOR:	R2.9 (140mm) Greenstuf Thermal Underfloor
	Blanket or similar
GLAZING:	R0.46

SHEET NAME Wall Framing Plan

CLIENT Sullivan Family DATE 1/10/2024 JOB NO. DW1475

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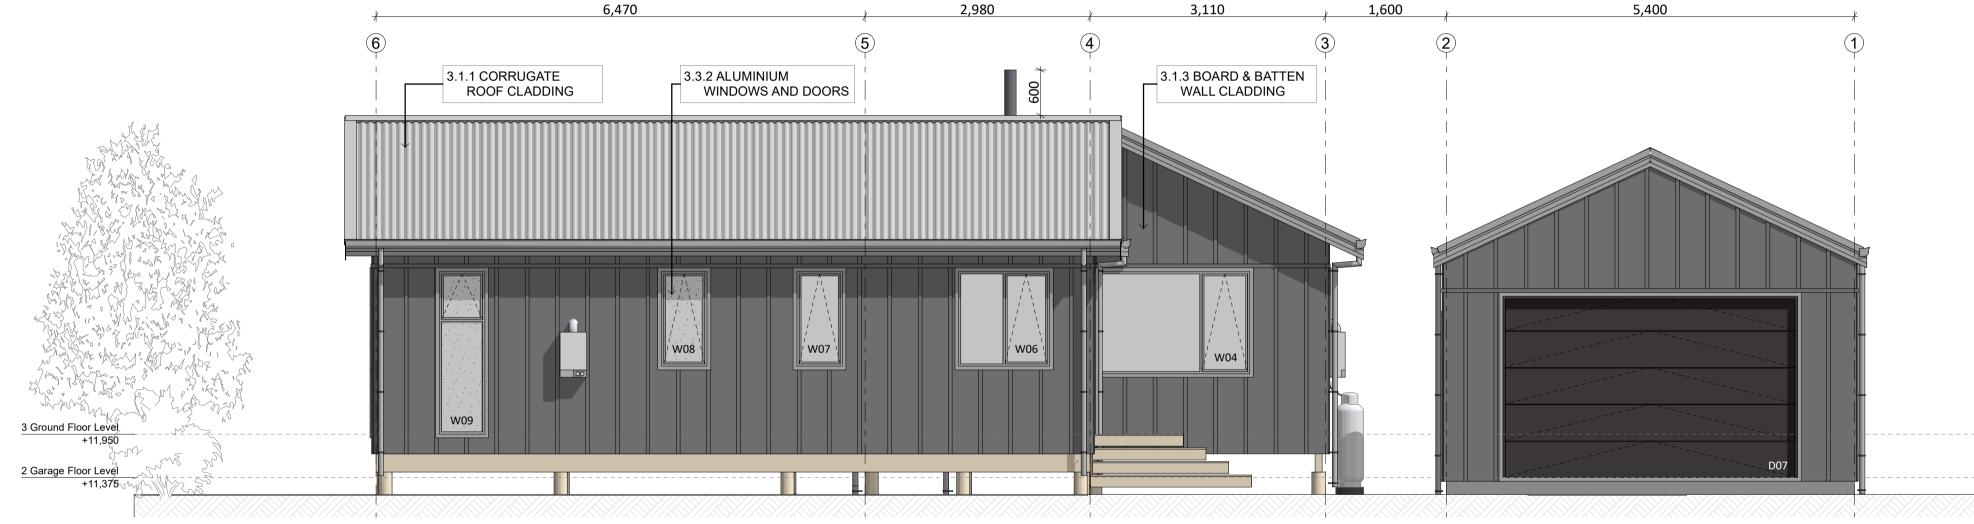




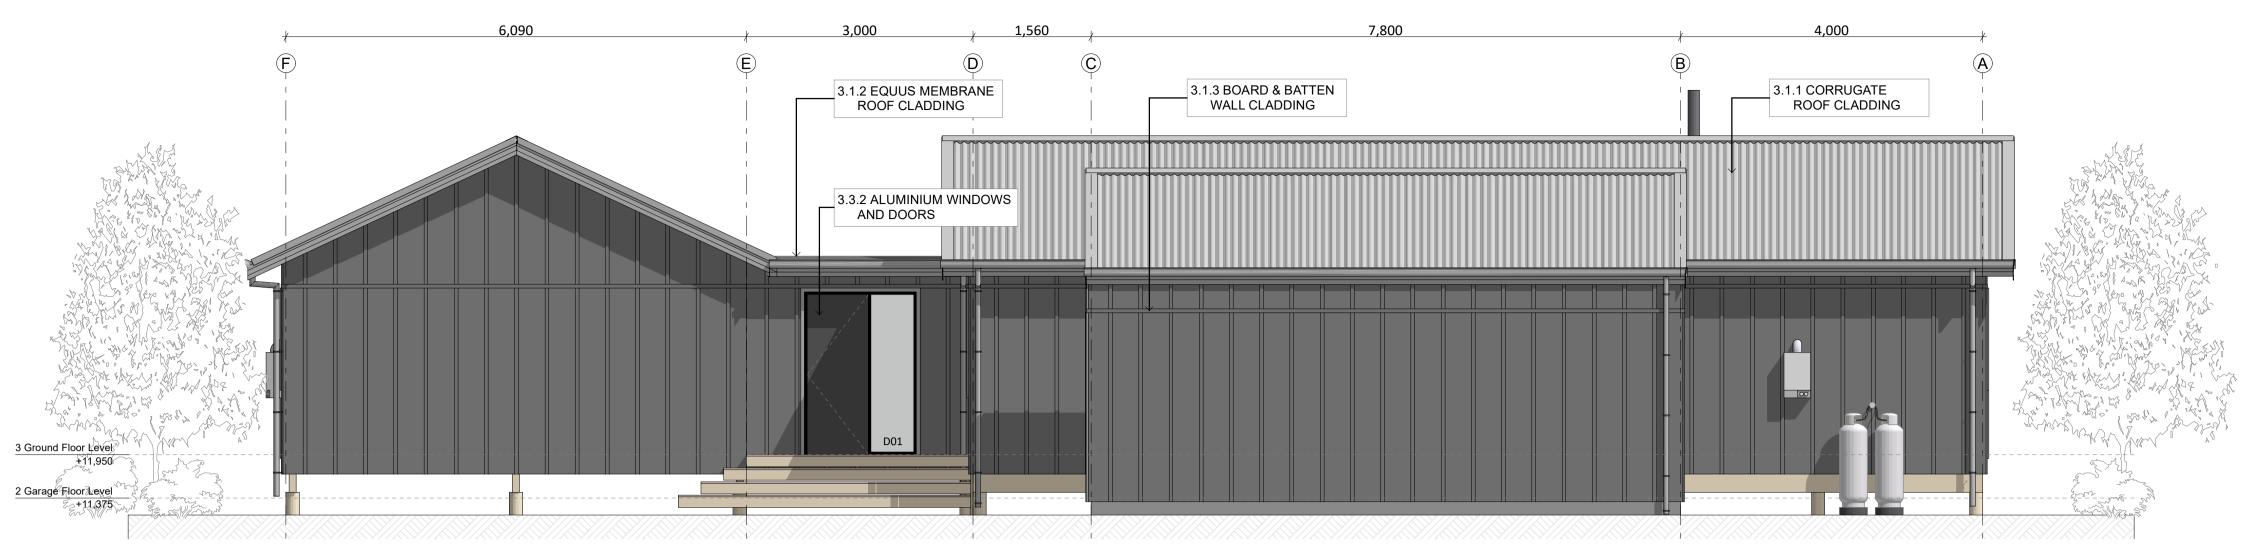
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E01 North Elevation SCALE 1:50



Sullivan Residence Lot 6, Moana

А	Concept Issue
В	Truss Issue
С	Building Consent Issue
D	Building Consent RFIs
Е	Truss & Engineer Issue
F	Amendment
G	Amendment RFIs
Н	Resource Consent Issue

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LEGE	ND
3.1.1	CORRUGATE ROOF CLADDING 0.40mm BMT Corrugate Colorsteel roofing system, on ex 75x50 H1.2 purlins at 900crs, building wrap and H1.2 rafters/trusses. refer framing plans for sizing and spacings extents
3.1.2	EQUUS MEMBRANE ROOF
	CLADDING
	Equus DuO Two Layer membrane system over 17.5mm CD grade H3 treated plywood (CCA) with a nominal fall of 2 deg.
3.1.3	BOARD & BATTEN WALL
	CLADDING
	Shadowclad Board & Batten cladding on 20mm cavity battens on 7mm Ecoply Barrier
3.3.2	ALUMINIUM WINDOWS AND
	DOORS
	Aluminium joinery system. Double glazed IGUs with Argon Gas and Low E coating. (Ug 1.1 LowE4/Clear (Argon) (Double)
	Powdercoat Finish to aluminium colour selected.
	- R0.46 Value

<u> Risk Matrix - North</u>	
Wind zone:	2
Number of storeys:	0
Roof/wall intersection:	0
Eaves width:	1
Envelope complexity:	0
Deck design:	<u>0</u>
TOTAL:	3
<u> Risk Matrix - East</u>	
Wind zone:	2
Number of storeys:	0
Roof/wall intersection:	-
Eaves width:	1
Envelope complexity:	0
Deck design:	<u>0</u>
TOTAL:	3
Risk Matrix - South	
Wind zone:	2
Number of storeys:	2
	0
•	Ο
Roof/wall intersection:	
Roof/wall intersection: Eaves width:	1
Roof/wall intersection: Eaves width: Envelope complexity:	1 0
Roof/wall intersection: Eaves width: Envelope complexity: Deck design:	1 0 <u>0</u>
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Roof/wall intersection: Eaves width: Envelope complexity: <u>Deck design:</u> TOTAL: <u>Risk Matrix - West</u>	1 0 <u>0</u> 3
Roof/wall intersection: Eaves width: Envelope complexity: <u>Deck design:</u> TOTAL: <u>Risk Matrix - West</u> Wind zone:	1 0 3 3
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sheet NAME Elevations

Sullivan Family

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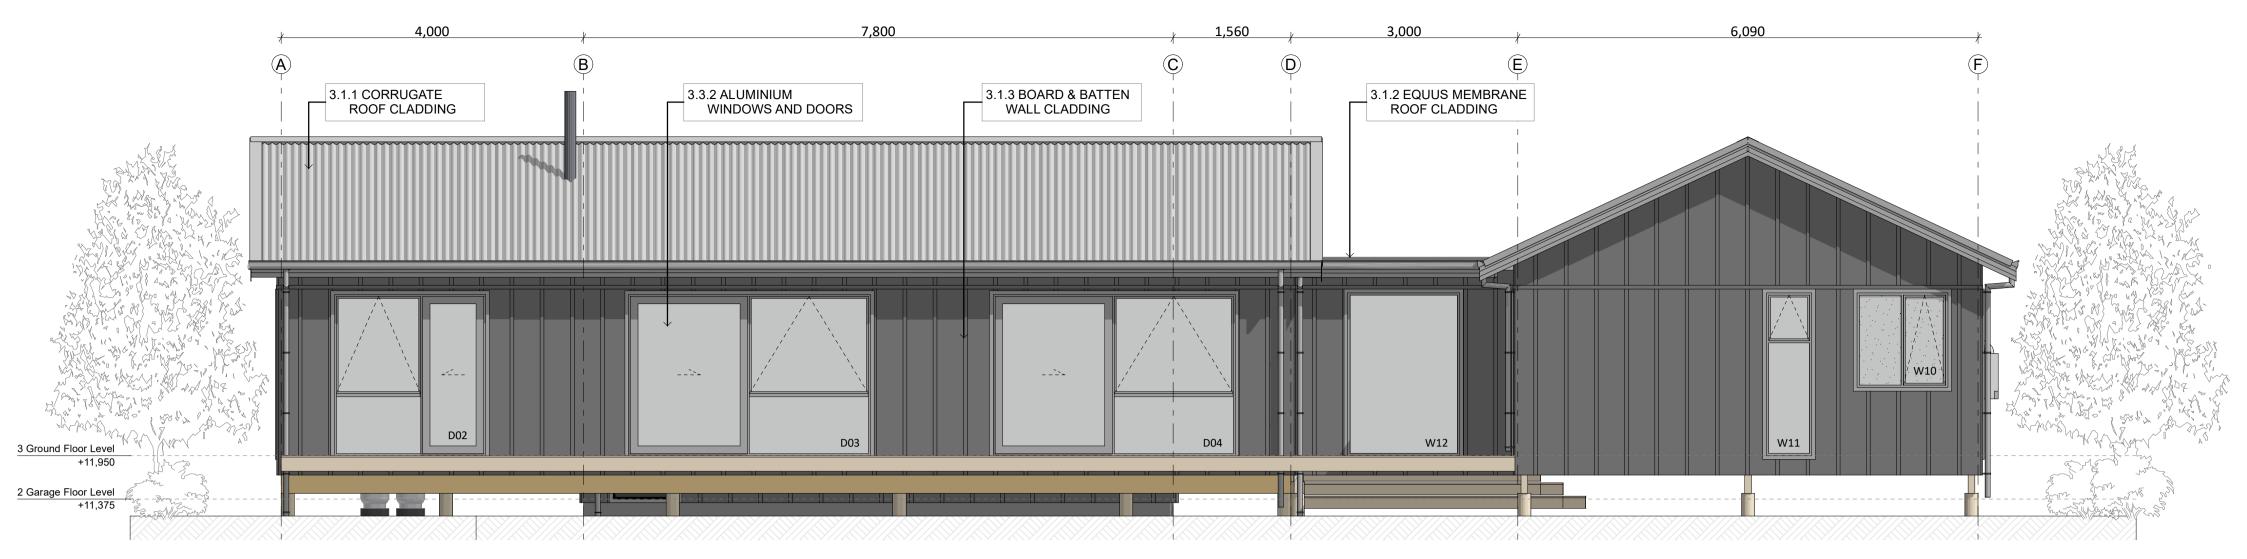
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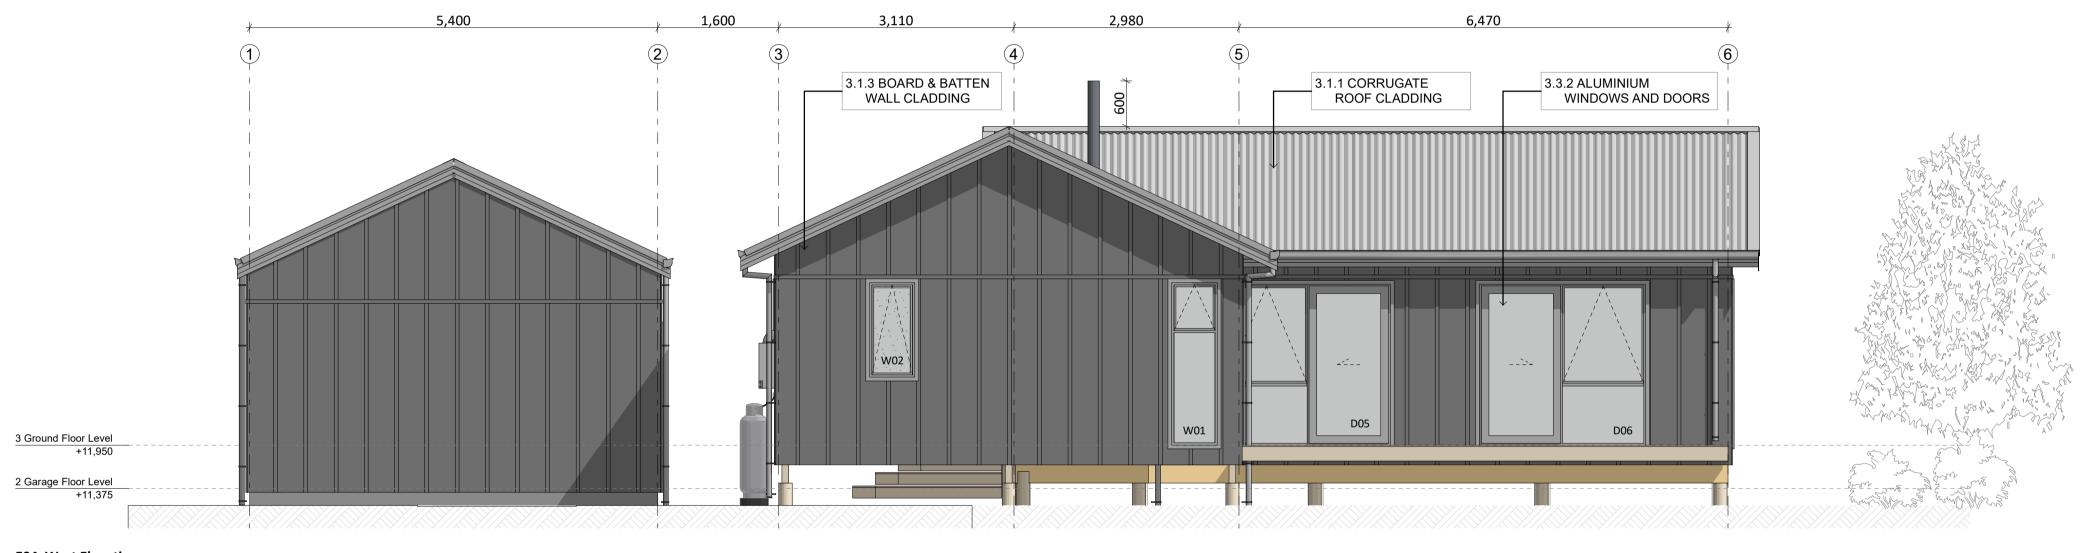


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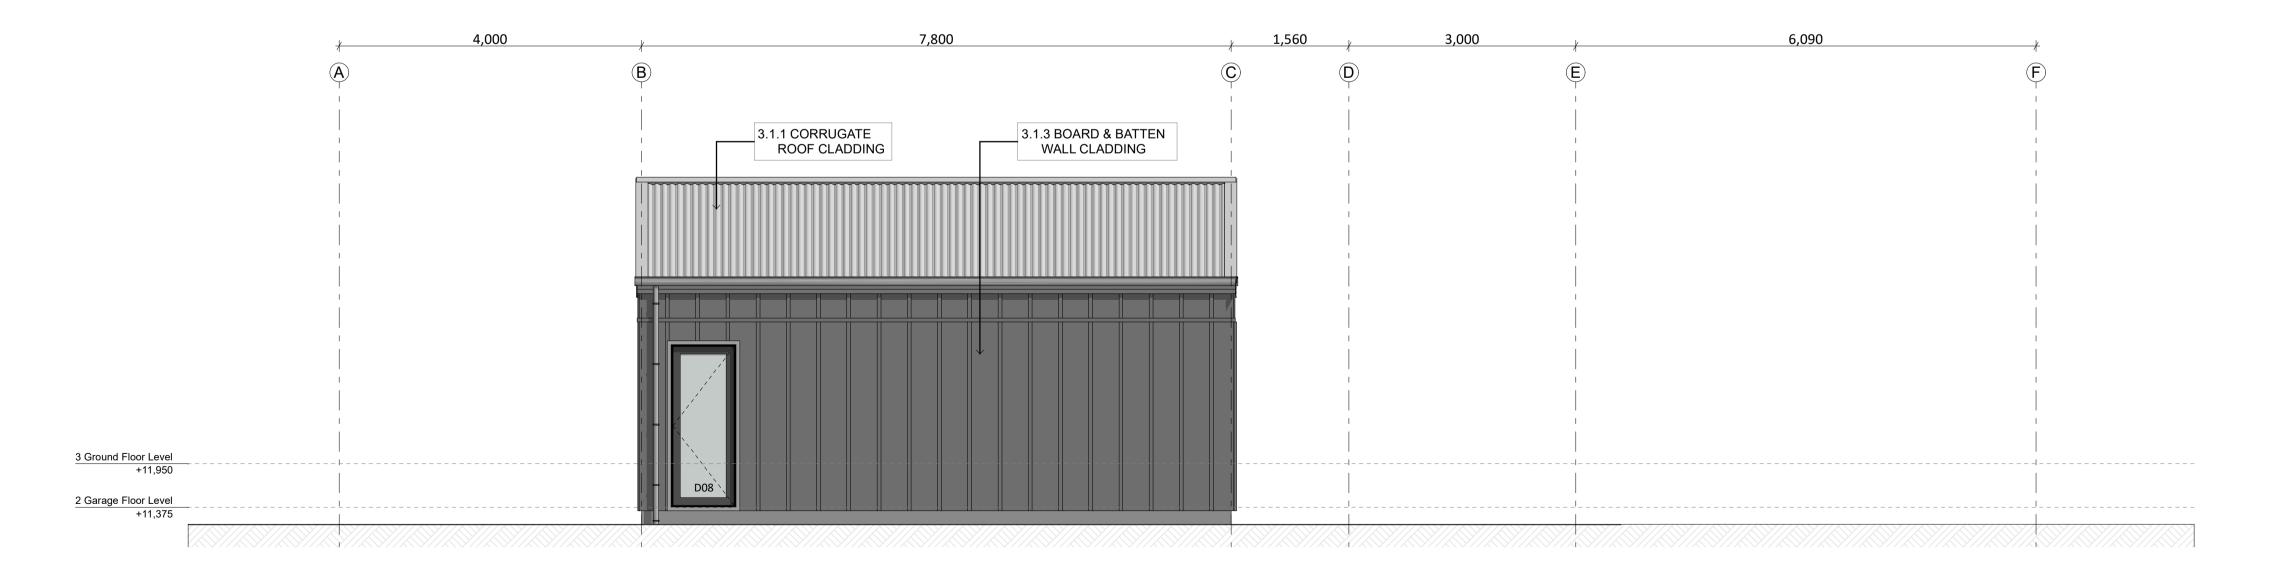
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EO3 South Elevation SCALE 1:50



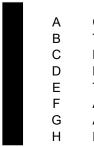
EO4 West Elevation
SCALE 1:50





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Eaves width:	1
Envelope complexity:	0
Deck design:	<u>0</u>
TOTAL:	3
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	2 0
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Wind zone: Number of storeys:	0
Wind zone: Number of storeys: Roof/wall intersection:	0 0
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